

Burlington

Sheet Index ID Name C-01 Cover B-01 Foundation Plan B-01.1 | Foundation Plan - Crawl B-02 Flatwork B-03 First Floor Plan B-04 Second Floor Plan S-01 Structural B-05 Elevations B-05.1 Elevations B-06 Secondary Elevations B-07 Roof Plan E-01 First Floor Electrical Plans E-02 Second Floor Electrical Plans H-01 Hardware and Bath Accessories Plan I-01 Information

Drawn By:
Tonya K./ Humberto L.
Date Plotted:
4/17/20

Original Date: 01/01/07

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Professional Engineer:

Revision Date Revision

Sheet Name:


Cover

Sheet Number:

C-01


FOUNDATION WALL	LEGEND
LOAD BEARING FOUNDATION WALL	EXXXXXX
LOCATION OF FIRST FLOOR WALLS ABOVE	[====]
SAW JOINTS	*
THICKENED SLAB	




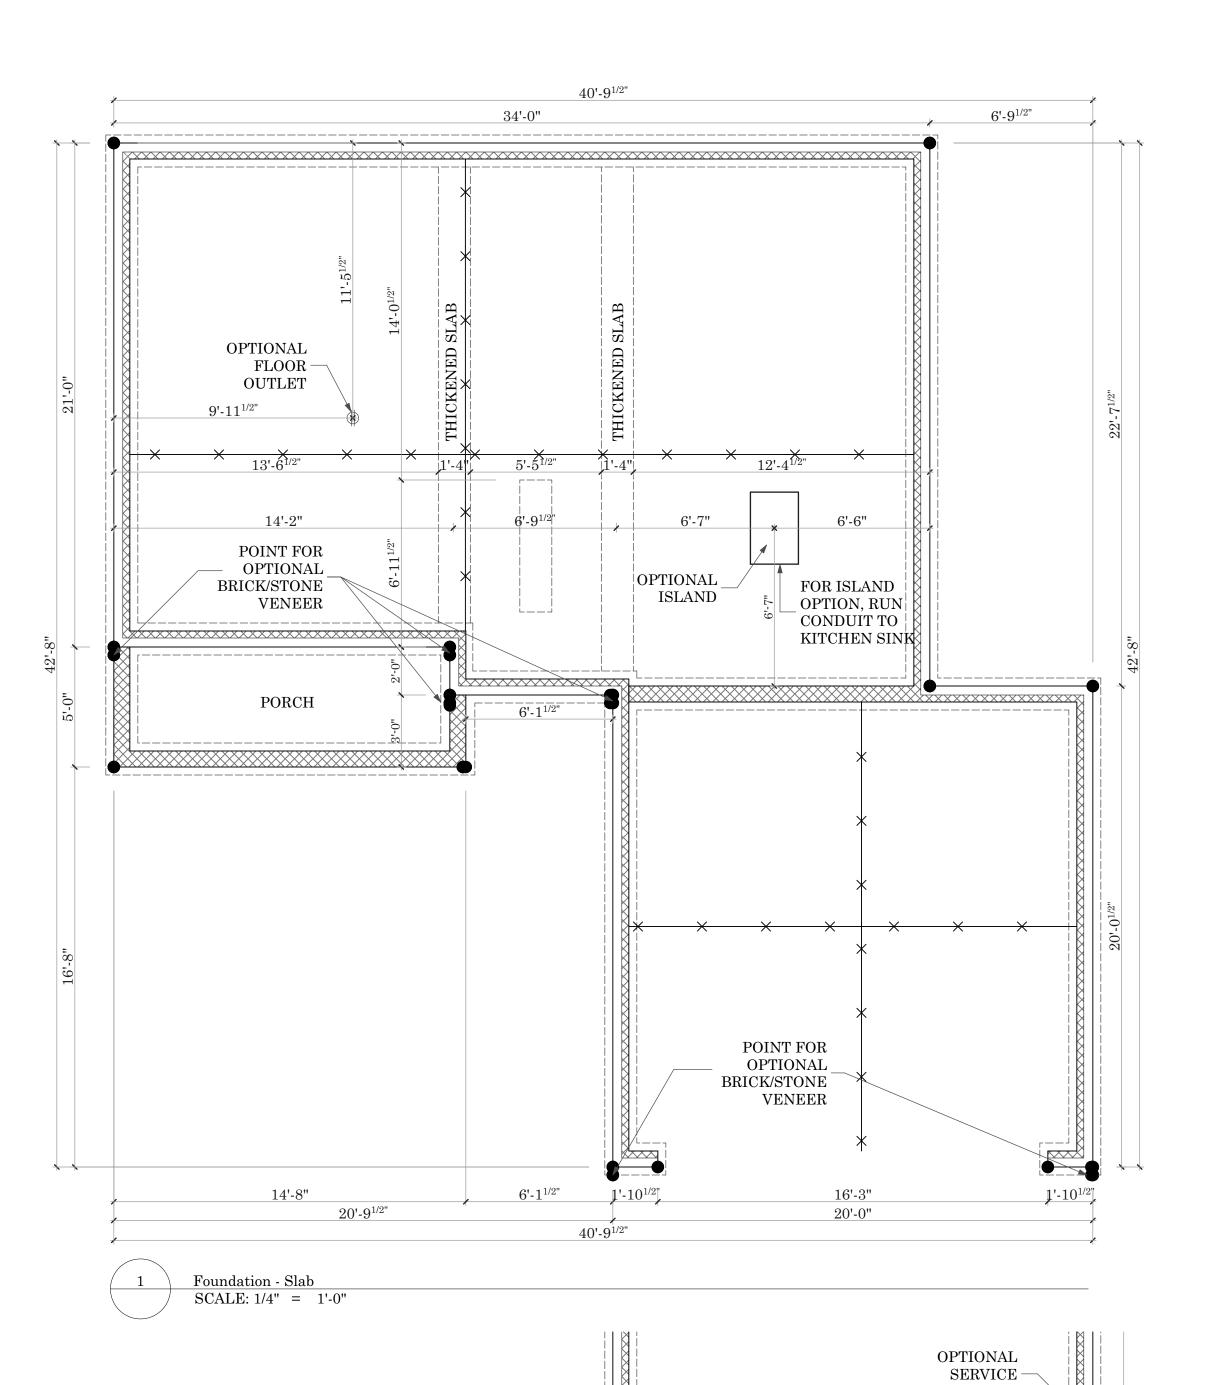

DOOR

Optional Service Door SCALE: 1/4" = 1'-0"

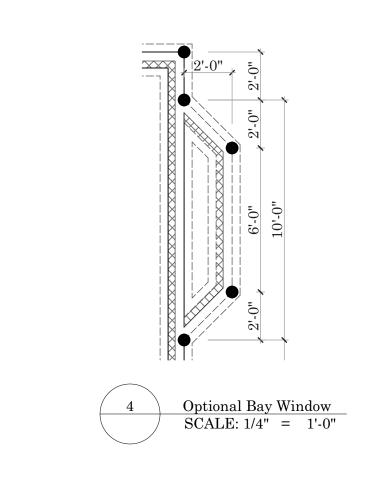

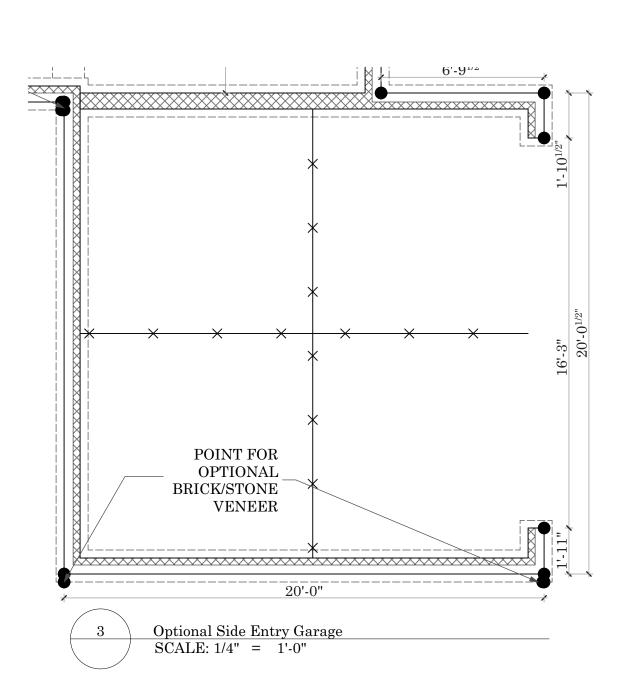

Burlington

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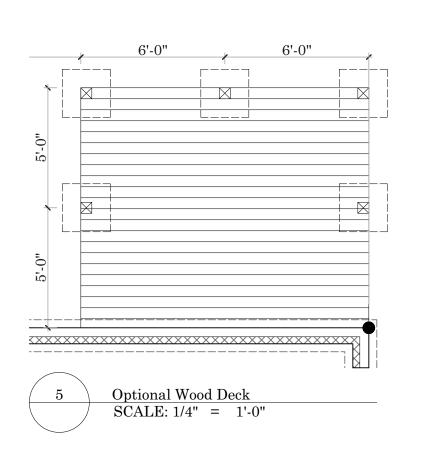
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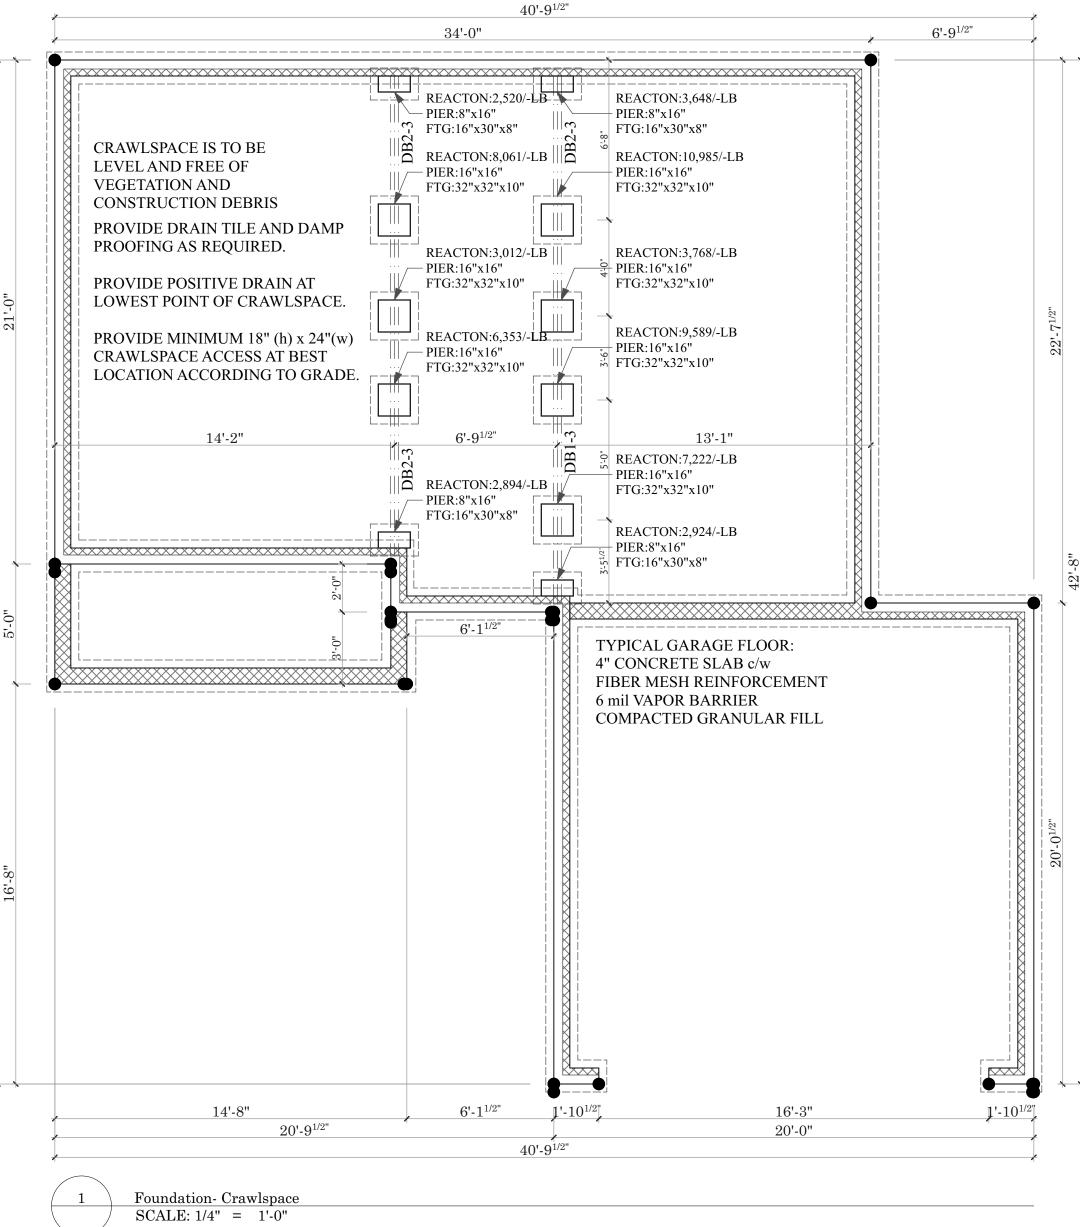
Revision Date	Revision
07/07/15	ADDED SIDE ENTRY GARAGE OPTION


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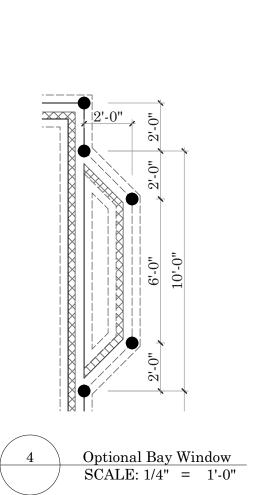
Foundation Plan


Sheet Number:







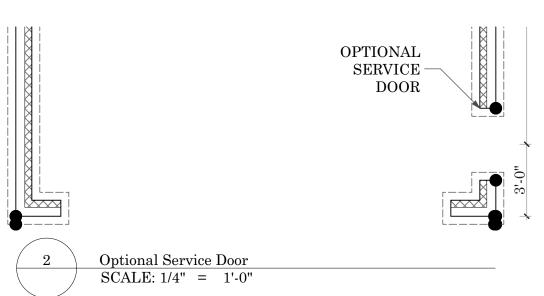

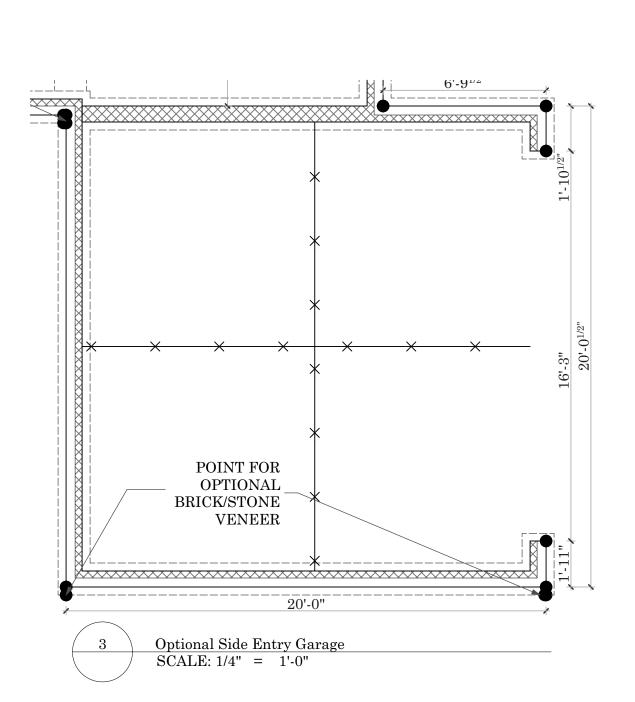



FOUNDATION WALL LEGEND

LOCATION OF FIRST FLOOR WALLS ABOVE

LOAD BEARING FOUNDATION WALL

SAW JOINTS

THICKENED SLAB

Burlington

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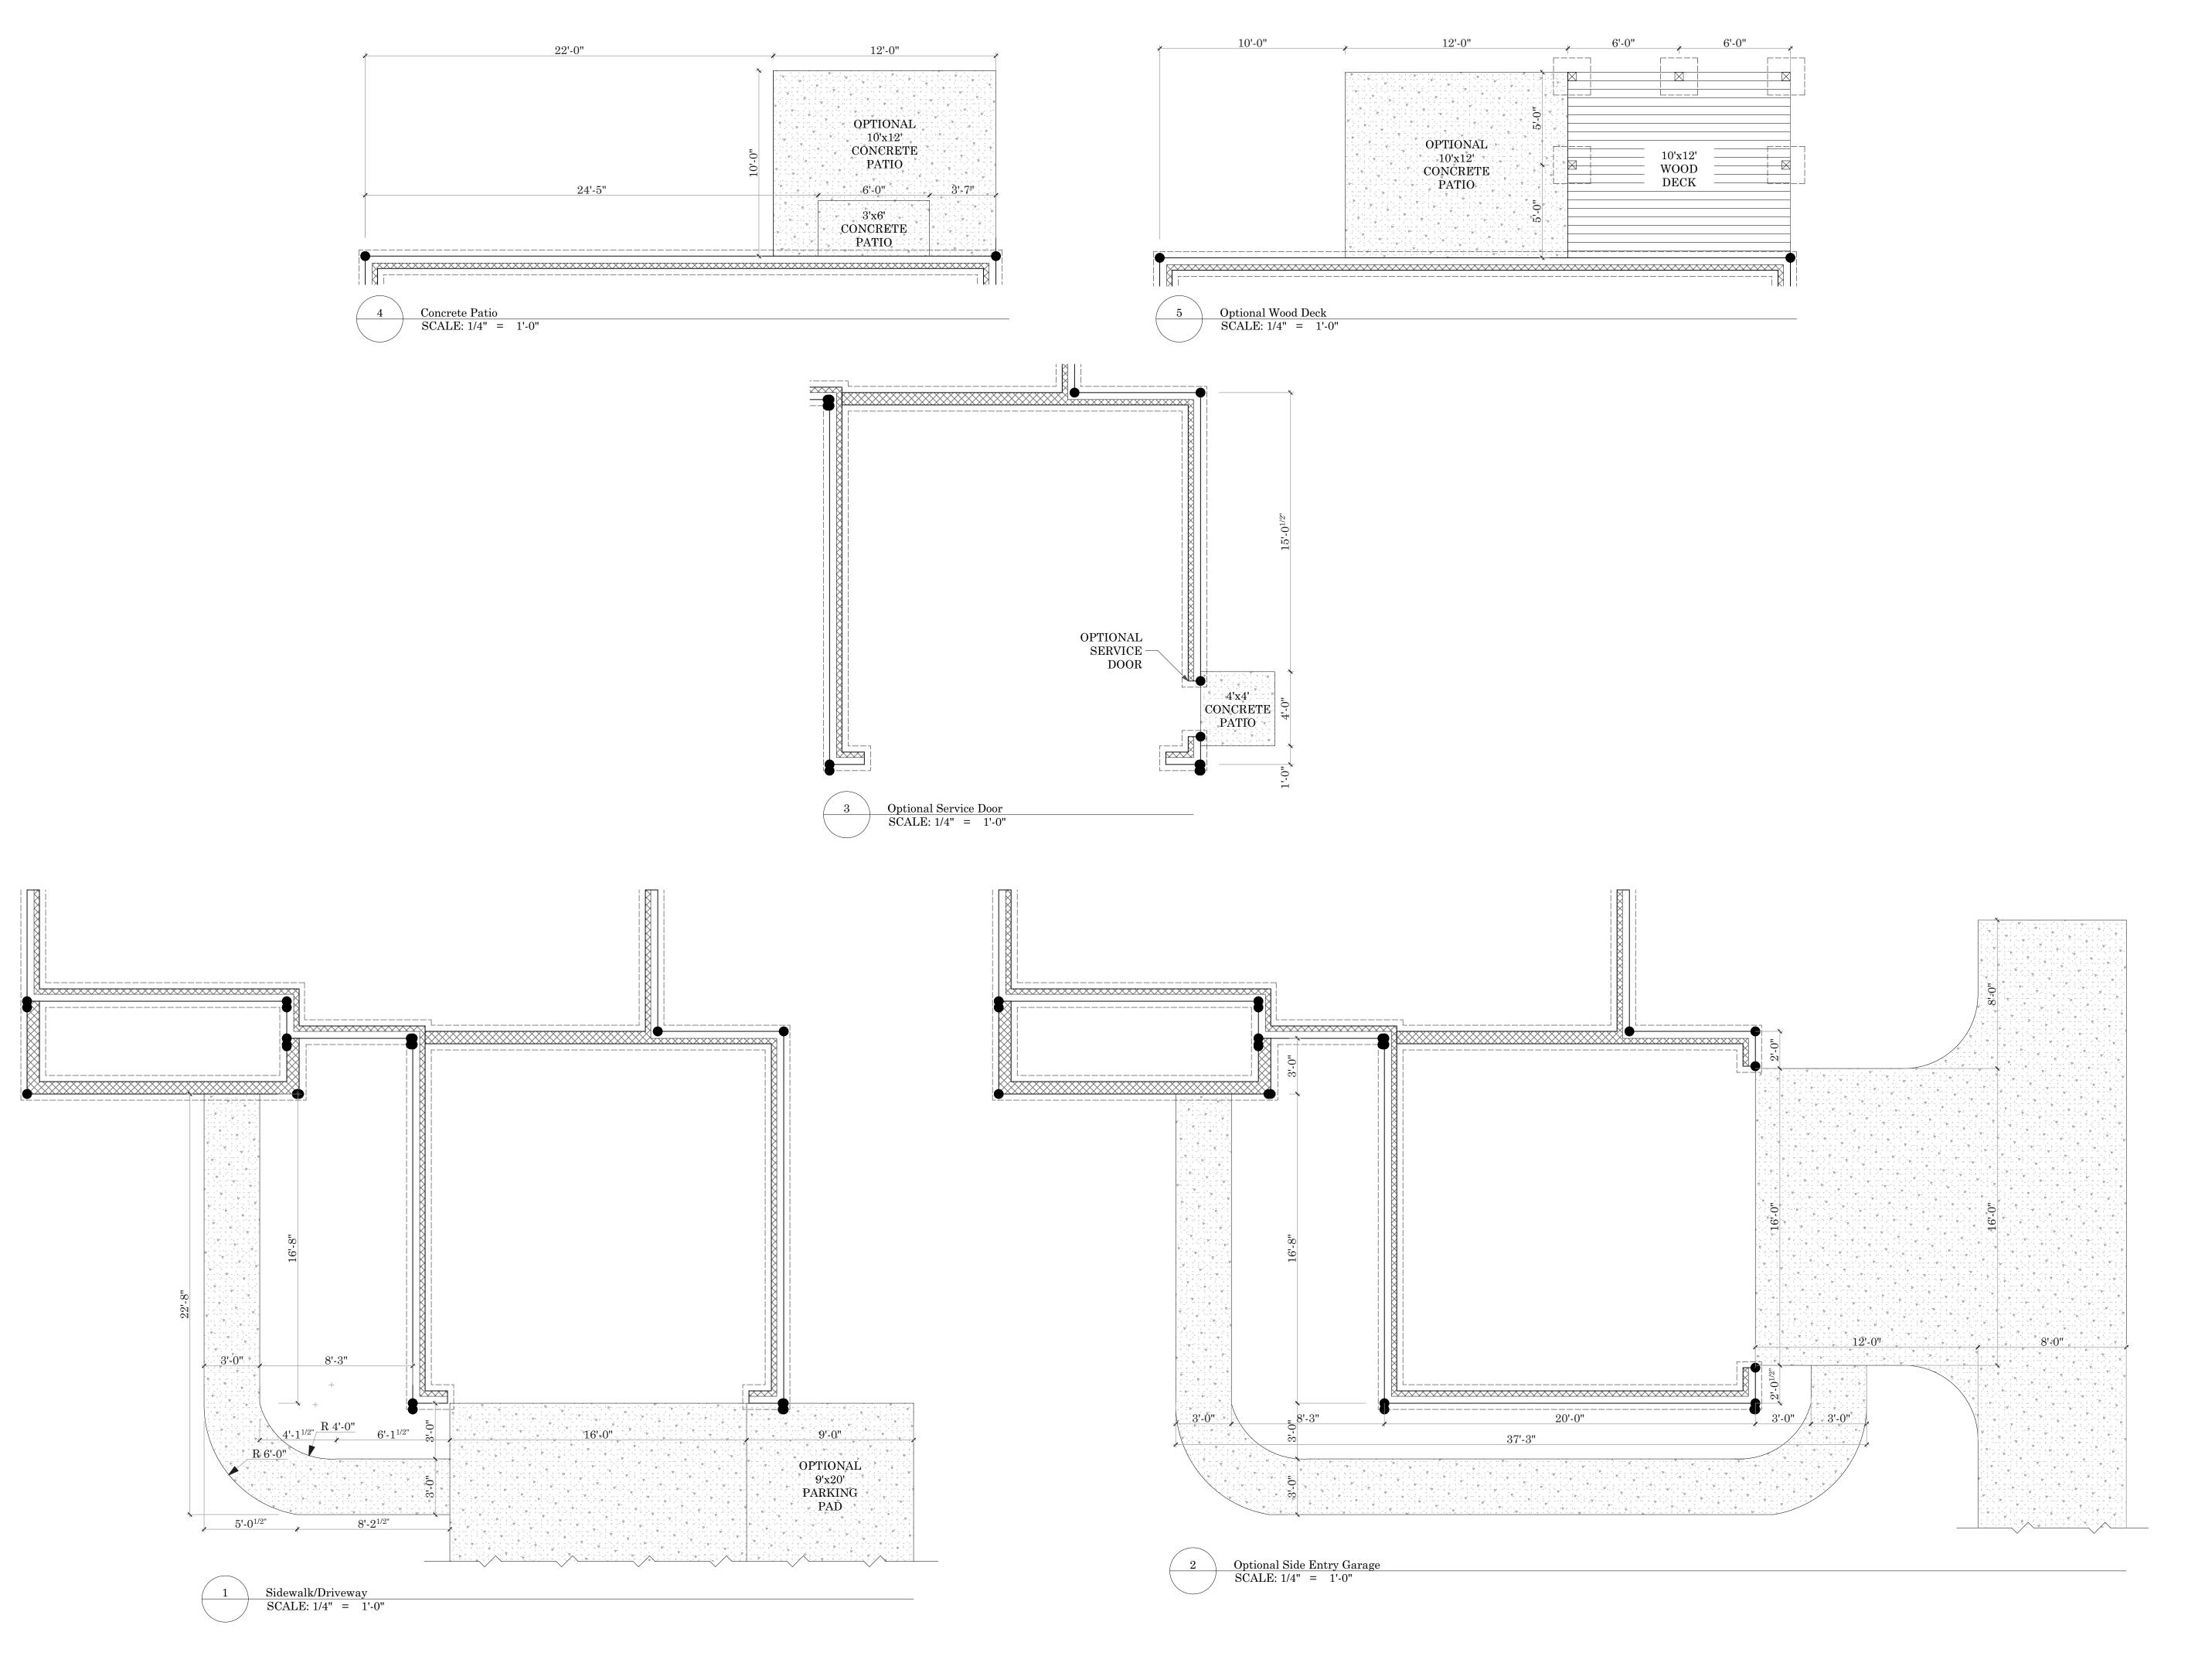
Revision Dat	te Revision
07/07/15	ADDED SIDE ENTRY GARAGE OPTION

Sheet Name:

Foundation Plan - Crawl

Sheet Number:

B-01.1





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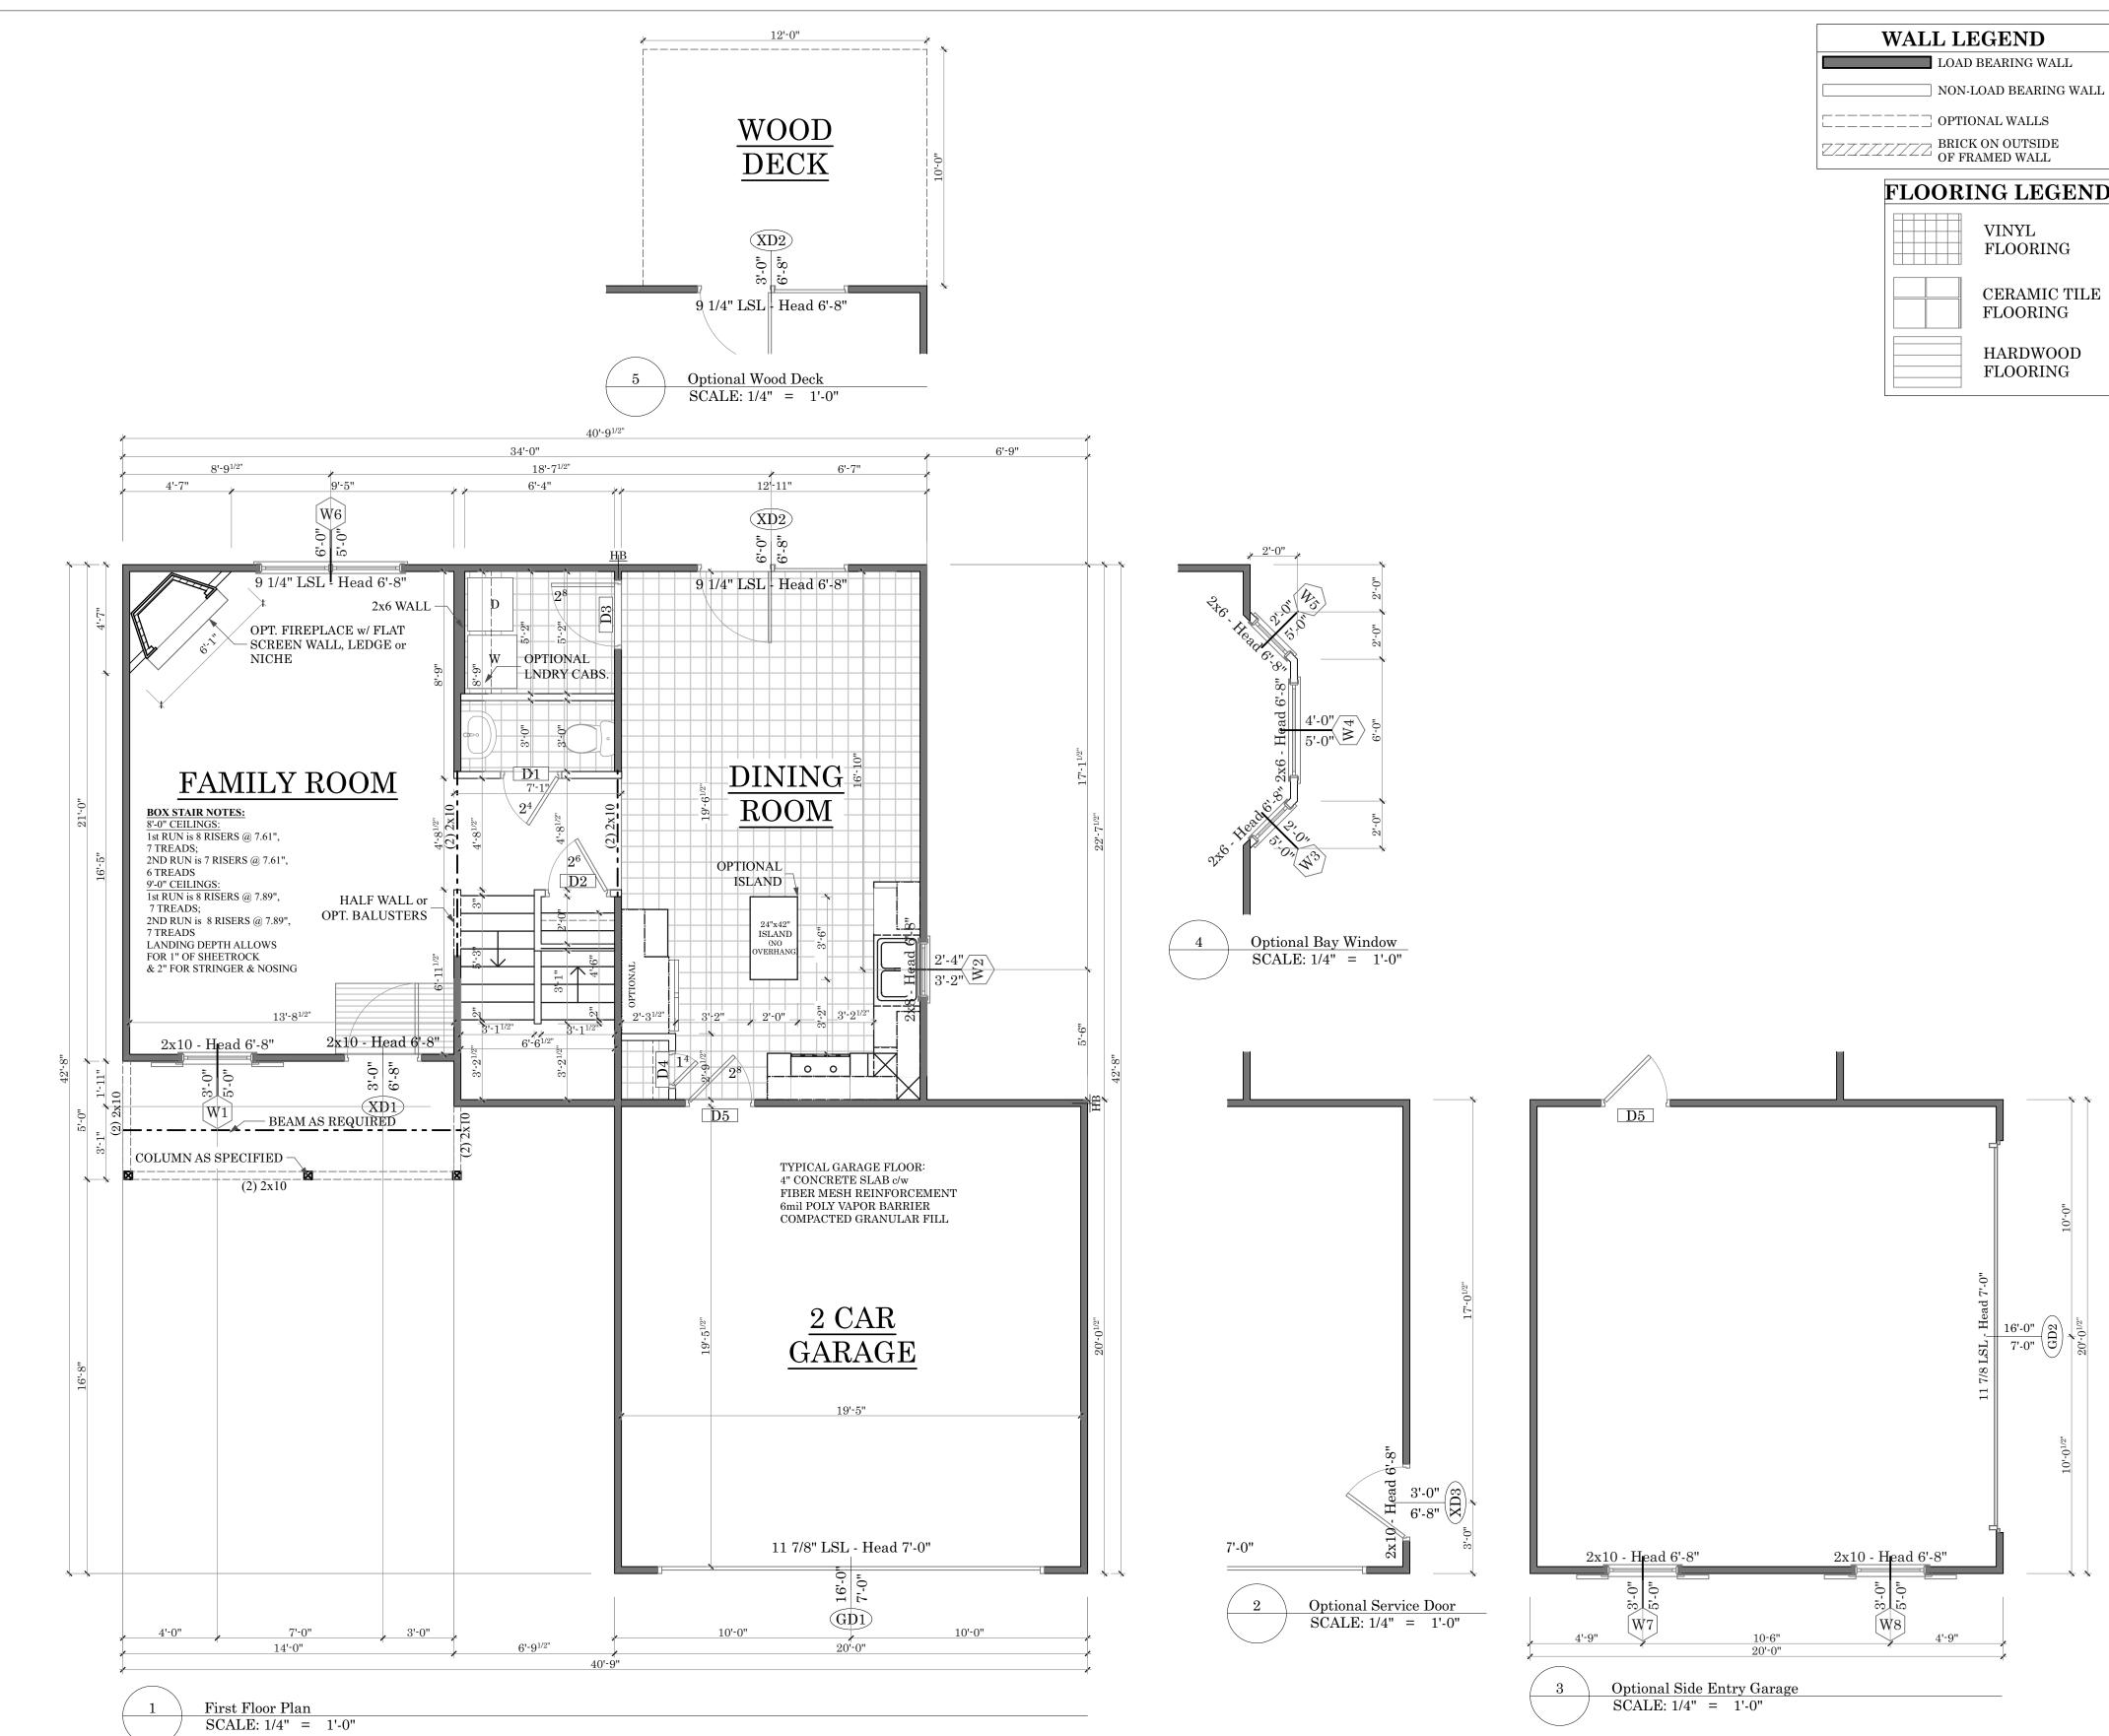
Professional Engineer:

Revision Date	Revision

Sheet Name:

Flatwork

Sheet Number:



	2'-6"x4'-6"	30"	54"
erable Single	2'-6"x5'-0"	30"	60 1/4"
erable Single	2'-8"x3'-2"	32"	38"
erable Single	2'-8"x4'-6"	32"	54"
erable Single	2'-8"x5'-0"	32"	60 1/4"
erable Single	3'-0"x3'-2"	36 1/4"	38"
erable Single	3'-0"x4'-6"	36 1/4"	54"
erable Single	3'-0"x5'-0"	36 1/4"	60 1/4"
r each mull, add 1/8".			
	Rough Openings: Doors		
Description	Rough Openings: Doors Plan Call Size	R.O. Width	R.O. Hei
Description Single Door		R.O. Width	R.O. Hei
	Plan Call Size		
	Plan Call Size	34 1/2"	83"
	Plan Call Size 2'-8" x 6'-8" 3'-0" x 6'-8"	34 1/2" 38 1/2"	83" 83"
Single Door	Plan Call Size 2'-8" x 6'-8" 3'-0" x 6'-8" 3'-0" x 6'-8" w/ ADA Threshold	34 1/2" 38 1/2" 38 1/2"	83" 83" 81 7/8"
Single Door	Plan Call Size 2'-8" x 6'-8" 3'-0" x 6'-8" 3'-0" x 6'-8" w/ ADA Threshold 2'-8" x 6'-8" w/ 10" Transom 2'-8" x 6'-8" w/ 12" Transom	34 1/2" 38 1/2" 38 1/2" 34 1/2"	83" 83" 81 7/8" 94 1/2"
Single Door	Plan Call Size 2'-8" x 6'-8" 3'-0" x 6'-8" 3'-0" x 6'-8" w/ ADA Threshold 2'-8" x 6'-8" w/ 10" Transom	34 1/2" 38 1/2" 38 1/2" 34 1/2" 34 1/2"	83" 83" 81 7/8" 94 1/2" 96 1/2"
Single Door	Plan Call Size 2'-8" x 6'-8" 3'-0" x 6'-8" 3'-0" x 6'-8" w/ ADA Threshold 2'-8" x 6'-8" w/ 10" Transom 2'-8" x 6'-8" w/ 12" Transom 3'-0" x 6'-8" w/ 10" Transom	34 1/2" 38 1/2" 38 1/2" 34 1/2" 34 1/2" 38 1/2"	83" 83" 81 7/8" 94 1/2" 96 1/2" 94 1/2"
Single Door with Transom	Plan Call Size 2'-8" x 6'-8" 3'-0" x 6'-8" 3'-0" x 6'-8" w/ ADA Threshold 2'-8" x 6'-8" w/ 10" Transom 2'-8" x 6'-8" w/ 12" Transom 3'-0" x 6'-8" w/ 10" Transom 3'-0" x 6'-8" w/ 12" Transom	34 1/2" 38 1/2" 38 1/2" 34 1/2" 34 1/2" 38 1/2" 38 1/2"	83" 83" 81 7/8" 94 1/2" 96 1/2" 96 1/2"
Single Door with Transom Single Door w/ Single Sidelite Single w/ Single Sidelites & Transom Single Door w/ Double Sidelite	Plan Call Size 2'-8" x 6'-8" 3'-0" x 6'-8" 3'-0" x 6'-8" w/ ADA Threshold 2'-8" x 6'-8" w/ 10" Transom 2'-8" x 6'-8" w/ 10" Transom 3'-0" x 6'-8" w/ 10" Transom 3'-0" x 6'-8" w/ 12" Transom 10" x 3'-0" (10" Sidelite)	34 1/2" 38 1/2" 38 1/2" 34 1/2" 34 1/2" 38 1/2" 38 1/2" 50"	83" 83" 81 7/8" 94 1/2" 96 1/2" 94 1/2" 96 1/2" 83"
Single Door with Transom Single Door w/ Single Sidelite Single w/ Single Sidelites & Transom	Plan Call Size 2'-8" x 6'-8" 3'-0" x 6'-8" w/ ADA Threshold 2'-8" x 6'-8" w/ 10" Transom 2'-8" x 6'-8" w/ 12" Transom 3'-0" x 6'-8" w/ 12" Transom 3'-0" x 6'-8" w/ 12" Transom 10" x 3'-0" (10" Sidelite) 10" x 3'-0" w/ 10" Transom	34 1/2" 38 1/2" 38 1/2" 34 1/2" 34 1/2" 38 1/2" 38 1/2" 50" 50"	83" 83" 81 7/8" 94 1/2" 96 1/2" 96 1/2" 83" 94 1/2"
Single Door with Transom Single Door w/ Single Sidelite Single w/ Single Sidelites & Transom Single Door w/ Double Sidelite	Plan Call Size 2'-8" x 6'-8" 3'-0" x 6'-8" w/ ADA Threshold 2'-8" x 6'-8" w/ 10" Transom 2'-8" x 6'-8" w/ 12" Transom 3'-0" x 6'-8" w/ 12" Transom 3'-0" x 6'-8" w/ 12" Transom 10" x 3'-0" (10" Sidelite) 10" x 3'-0" w/ 10" Transom	34 1/2" 38 1/2" 38 1/2" 34 1/2" 34 1/2" 38 1/2" 38 1/2" 50" 50"	83" 83" 81 7/8" 94 1/2" 96 1/2" 96 1/2" 83" 94 1/2"

5'-4" x 6'-8" w/ 10" Transom 5'-4" x 6'-8"w/ 12" Transom 6'-0" x 6'-8" w/ 10" Transom 6'-0" x 6'-8" w/ 12" Transom

1'-0" x 3'-0"x 1'-0" (12" Sidelites, Ellip. Transom) 65 1/2"

Rough Openings: Windows (MI 3500 & 4300 Series)

Description

Fixed Single Fixed Single Fixed Transom

Fixed Single
Operable Single
Operable Single

Operable Single

Operable Single

Operable Single
Operable Single
Operable Single

Operable Single

Operable Single Operable Single Operable Single

ouble Center Hinge

Plan Call Size

2'-0"x2'-0" 3'-0"x3'-0"

4'-0"x1'-0"

4'-0"x4'-0"

2'-0"x3'-2" 2'-0"x4'-6" 2'-0"x 5'-0" 2'-4"x3'-2" 2'-4"x4'-6" 2'-4"x5'-0" 2'-6"x3'-2" 2'-6"x4'-6"

R.O. Width R.O. Height

48 1/4" 12" 48 1/4" 48 1/4"

60 1/4" 38"

	First Floor Door List				
Mark	WxH	Cut Header From	Jacks	Description	
D1	2'-4"×6'-8"	2x4	1	Standard, 2 Panel, Moulded	
D2	2'-6"×6'-8"	2x4	1	Standard, 2 Panel, Moulded	
D3	2'-8"×6'-8"	2x4	1	Standard, 2 Panel, Moulded	
D4	1'-4"×6'-8"	2x4	1	Standard, 2 Panel, Moulded	
D5	2'-8"×6'-8"	2x10	3	Standard, 2 Panel, CS, 20 Min. Rated	
GD1	16'-0"×7'	3 1/2"x 11 7/8" LSL	3	Standard, Roll-Up, Steel	
GD2	16'-0"×7'	3 1/2"x 11 7/8" LSL	3	Optional, Roll Up, Steel	
XD1	3'-0"×6'-8"	2x10	3	Standard, 6 Panel, CS	
XD2	6'-0"×6'-8"	3 1/2"x 9 1/4" LSL	3	Standard, 1 lite, Center-hinge, CS	
XD3	3'-0"×6'-8"	2x10	3	Standard, 6 Panel, CS	

First Floor Window List				
Mark	$W \times H$	Cut Header From	Jacks	Description
W1	3'-0"×5'-0"	2x10	2	Standard, 3050, Single, Vinyl, 4/4 Mullions
W2	2'-4"×3'-2"	2x8	1	Standard, 2432, Single, Vinyl, 4/4 Mullions
W3	2'-0"×5'-0"	2x6	1	Optional, 2050, Single, Vinyl, 4/4 Mullions
W4	4'-0"×5'-0"	2x6	1	Optional, 4050, Single, Vinyl, 4/4 Mullions
W5	2'-0"×5'-0"	2x6	1	Optional, 2050, Single, Vinyl, 4/4 Mullions
W6	6'-0"×5'-0"	3 1/2"x 9 1/4" LSL	3	Standard, 3050, Twin, Vinyl, 4/4 Mullions
W7	3'-0"×5'-0"	2x10	3	Optional, 3050, Single, Vinyl, 4/4 Mullions
W8	3'-0"×5'-0"	2x10	3	Optional, 3050, Single, Vinyl, 4/4 Mullions



Burlington

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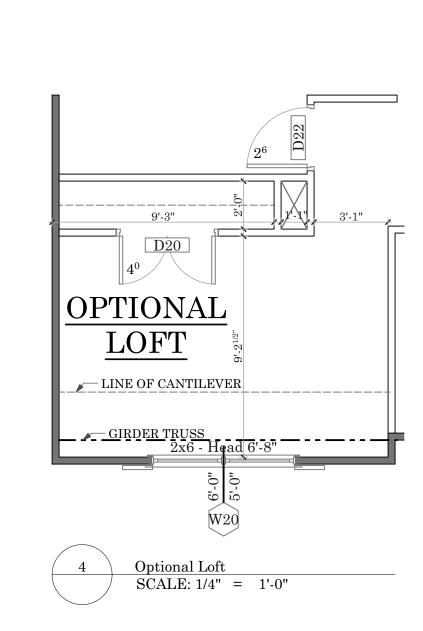
Professional Engineer:

DED SIDE ENTRY ARAGE OPTION NGED 1ST FLOOR DOWS TO 5'-0" HT.
EEASED WIDTH OF AB ABOVE REF.
IANGED ISLAND IE FROM 24x36 to 24x42

Sheet Name:


First Floor Plan


Sheet Number:




Description	Plan Call Size	R.O. Width	R.O. Height
Fixed Single	2'-0"x2'-0"	24"	24"
Fixed Single	3'-0"x3'-0"	36 1/4"	36"
Fixed Transom	4'-0"x1'-0"	48 1/4"	12"
Fixed Single	4'-0"x4'-0"	48 1/4"	48 1/4"
Operable Single	2'-0"x3'-2"	24"	38"
Operable Single	2'-0"x4'-6"	24"	54"
Operable Single	2'-0"x 5'-0"	24"	60 1/4"
Operable Single	2'-4"x3'-2"	28"	38"
Operable Single	2'-4"x4'-6"	28"	54"
Operable Single	2'-4"x5'-0"	28"	60 1/4"
Operable Single	2'-6"x3'-2"	30"	38"
Operable Single	2'-6"x4'-6"	30"	54"
Operable Single	2'-6"x5'-0"	30"	60 1/4"
Operable Single	2'-8"x3'-2"	32"	38"
Operable Single	2'-8"x4'-6"	32"	54"
Operable Single	2'-8"x5'-0"	32"	60 1/4"
Operable Single	3'-0"x3'-2"	36 1/4"	38"
Operable Single	3'-0"x4'-6"	36 1/4"	54"
Operable Single	3'-0"x5'-0"	36 1/4"	60 1/4"

Rough Openings: Doors						
Description	Plan Call Size	R.O. Width	R.O. Height			
Single Door	2'-8" x 6'-8"	34 1/2"	83"			
	3'-0" x 6'-8"	38 1/2"	83"			
	3'-0" x 6'-8" w/ ADA Threshold	38 1/2"	81 7/8"			
Single Door with Transom	2'-8" x 6'-8" w/ 10" Transom	34 1/2"	94 1/2"			
	2'-8" x 6'-8" w/ 12" Transom	34 1/2"	96 1/2"			
	3'-0" x 6'-8" w/ 10" Transom	38 1/2"	94 1/2"			
	3'-0" x 6'-8" w/ 12" Transom	38 1/2"	96 1/2"			
Single Door w/ Single Sidelite	10" x 3'-0" (10" Sidelite)	50"	83"			
Single w/ Single Sidelites & Transom	10" x 3'-0" w/ 10" Transom	50"	94 1/2"			
Single Door w/ Double Sidelite	1'-0" x 3'-0"x 1'-0" (12" Sidelites)	65-1/2"	83"			
Single Door w/ Double Sidelites &						
Transom	1'-0" x 3'-0"x 1'-0" (12" Sidelites, 12" Transom)	65 1/2"	96 1/2"			
Single Door w/ Double Sidelites &						
Ellip.Transom	1'-0" x 3'-0"x 1'-0" (12" Sidelites, Ellip. Transom)	65 1/2"	100 1/2"			
Double Center Hinge	5'-4" x 6'-8"	68"	83"			
	6'-0" x 6'-8"	76"	83"			
Double Center Hinge & Transom	5'-4" x 6'-8" w/ 10" Transom	68"	94 1/2"			
	5'-4" x 6'-8"w/ 12" Transom	68"	96 1/2"			
	6'-0" x 6'-8" w/ 10" Transom	76"	94 1/2"			
	6'-0" x 6'-8" w/ 12" Transom	76"	96 1/2"			

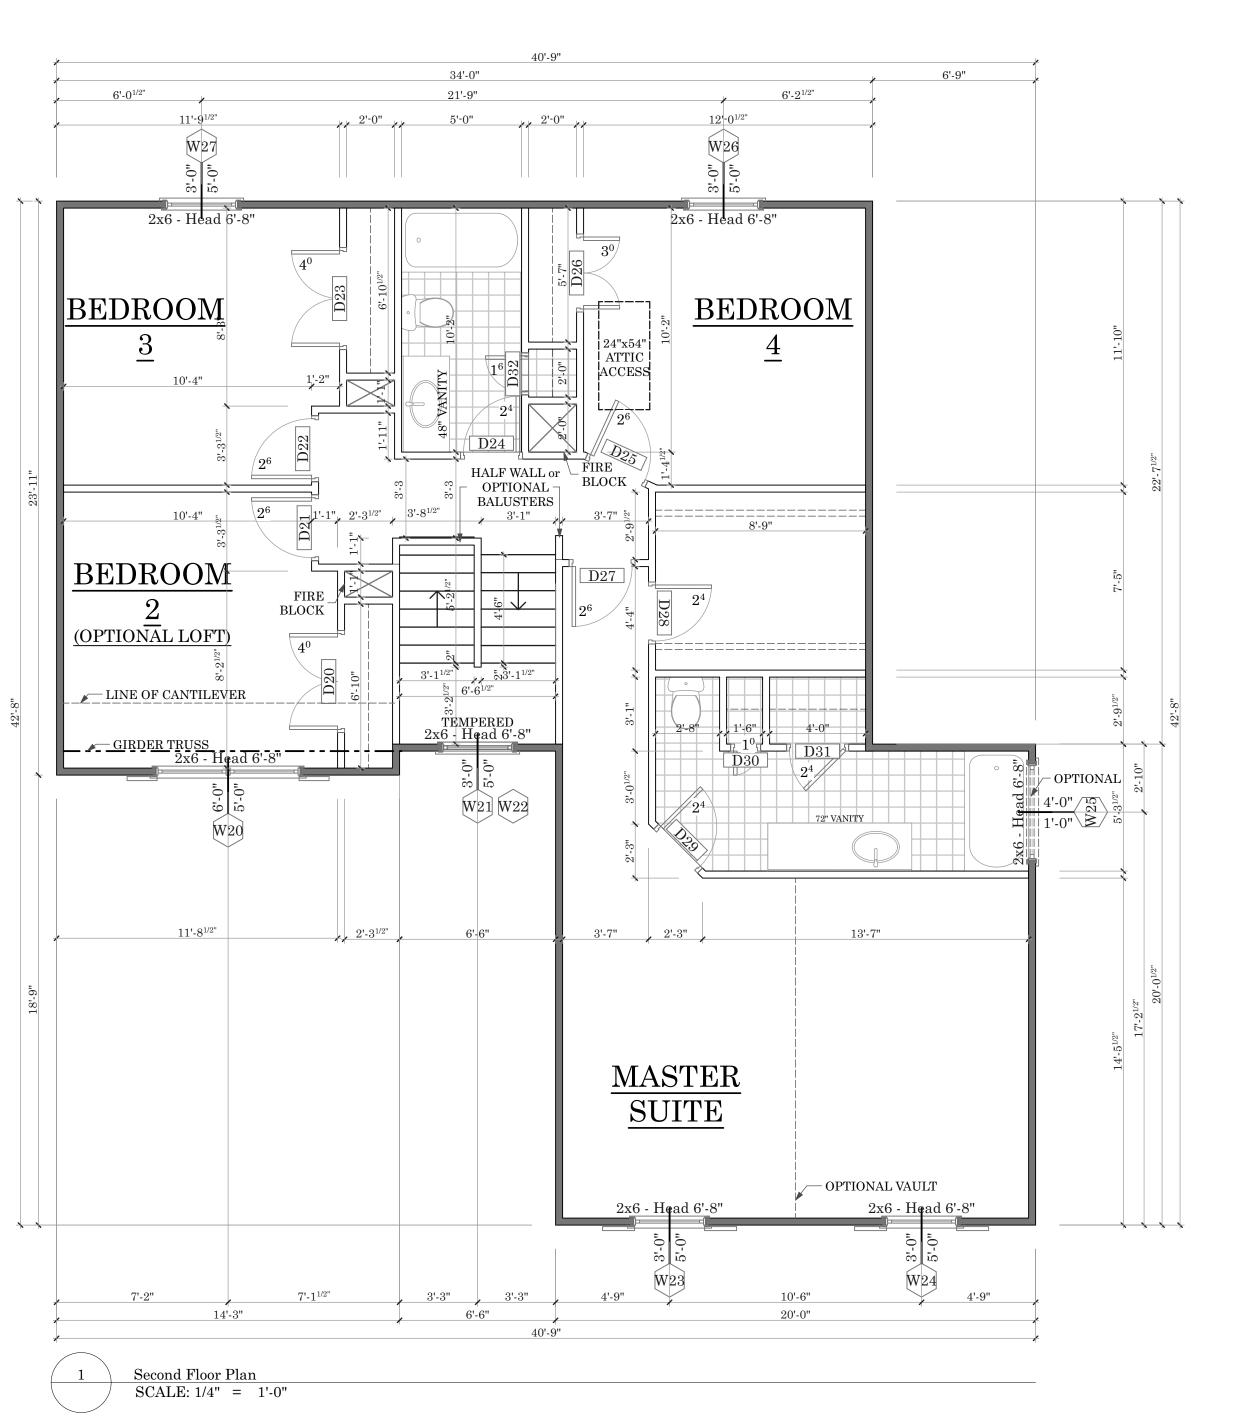

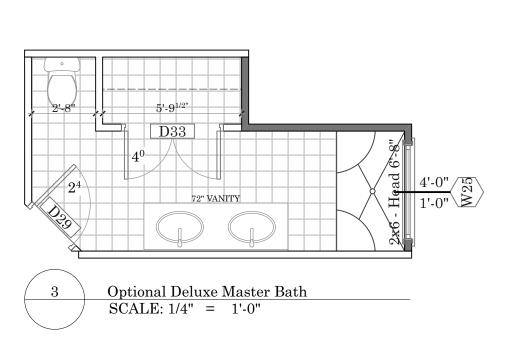

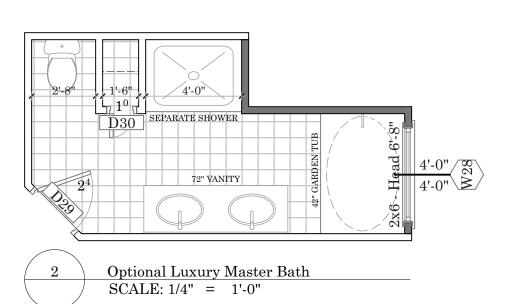

	Second Floor Door List				
Mark	WxH	Cut Header From	Jacks	Description	
D20	4'-0"×6'-8"	2x4	1	Standard, 2 Panel, Bi-Hinge, Moulded	
D21	2'-6"×6'-8"	2x4	1	Standard, 2 Panel, Moulded	
D22	2'-6"×6'-8"	2x4	1	Standard, 2 Panel, Moulded	
D23	4'-0"×6'-8"	2x4	1	Standard, 2 Panel, Bi-Hinge, Moulded	
D24	2'-4"×6'-8"	2x4	1	Standard, 2 Panel, Moulded	
D25	2'-6"×6'-8"	2x4	1	Standard, 2 Panel, Moulded	
D26	3'-0"×6'-8"	2x4	1	Standard, 2 Panel, Bi-Hinge, Moulded	
D27	2'-6"×6'-8"	2x4	1	Standard, 2 Panel, Moulded	
D28	2'-4"×6'-8"	2x4	1	Standard, 2 Panel, Moulded	
D29	2'-4"×6'-8"	2x4	1	Standard, 2 Panel, Moulded	
D30	1'-0"×6'-8"	2x4	1	Standard, 2 Panel, Moulded	
D31	2'-4"×6'-8"	2x4	1	Standard, 2 Panel, Moulded	
D32	1'-6"×6'-8"	2x4	1	Standard, 2 Panel, Moulded	
D33	4'-0"×6'-8"	2x4	1	Optional, 2 Panel, Bi-Hinge, Moulded	

	Second Floor Window List				
Mark	WxH	Cut Header From	Jacks	Description	
W20	6'-0"×5'-0"	(2) 2x6	1	Standard, 3050, Twin, Vinyl, 4/4 Mullions	
W21	3'-0"×5'-0"	(2) 2x6	1	Standard, 3050, Twin, Vinyl, 4/4 Mullions	
W22	3'-0"×1'-6 ¹	(2) 2x6	1	Standard, Half Round, Vinyl	
W23	3'-0"×5'-0"	(2) 2x6	1	Standard, 3050, Twin, Vinyl, 4/4 Mullions	
W24	3'-0"×5'-0"	(2) 2x6	1	Standard, 3050, Twin, Vinyl, 4/4 Mullions	
W25	4'-0"×1'-0"	(2) 2x6	1	Optional, 4010, Transom, Vinyl, 4 lite	
W26	3'-0"×5'-0"	(2) 2x6	1	Standard, 3050, Twin, Vinyl, 4/4 Mullions	
W27	3'-0"×5'-0"	(2) 2x6	1	Standard, 3050, Twin, Vinyl, 4/4 Mullions	
W28	4'-0"×4'-0"	(2) 2x6	1	Optional, 4040, Tempered, Obscure, 16 lite	

WALL LEGEND

LOAD BEARING WALL

LOAD BEARING WALL
NON-LOAD BEARING WALI

OPTIONAL WALLS

BRICK ON OUTSIDE OF FRAMED WALL

FLOORING LEGEND

VINYL FLOORING

CERAMIC TILE FLOORING

HARDWOOD FLOORING



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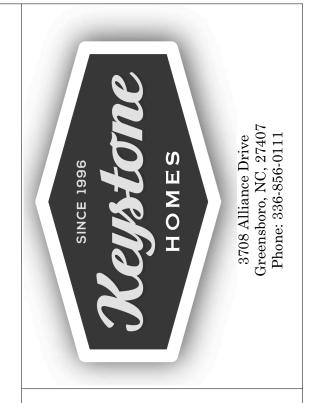
Professional Engineer:

Revision Date	Revision
03.12.12	CHANGED STAIR WINDOW TO TEMPERED
03.15.12	ADDED OPTIONAL LOFT
11.21.14	CHANGED 2ND FLOOR WINDOWS TO 5'-0" HT.

Sheet Name:

Second Floor Plan

Sheet Number:



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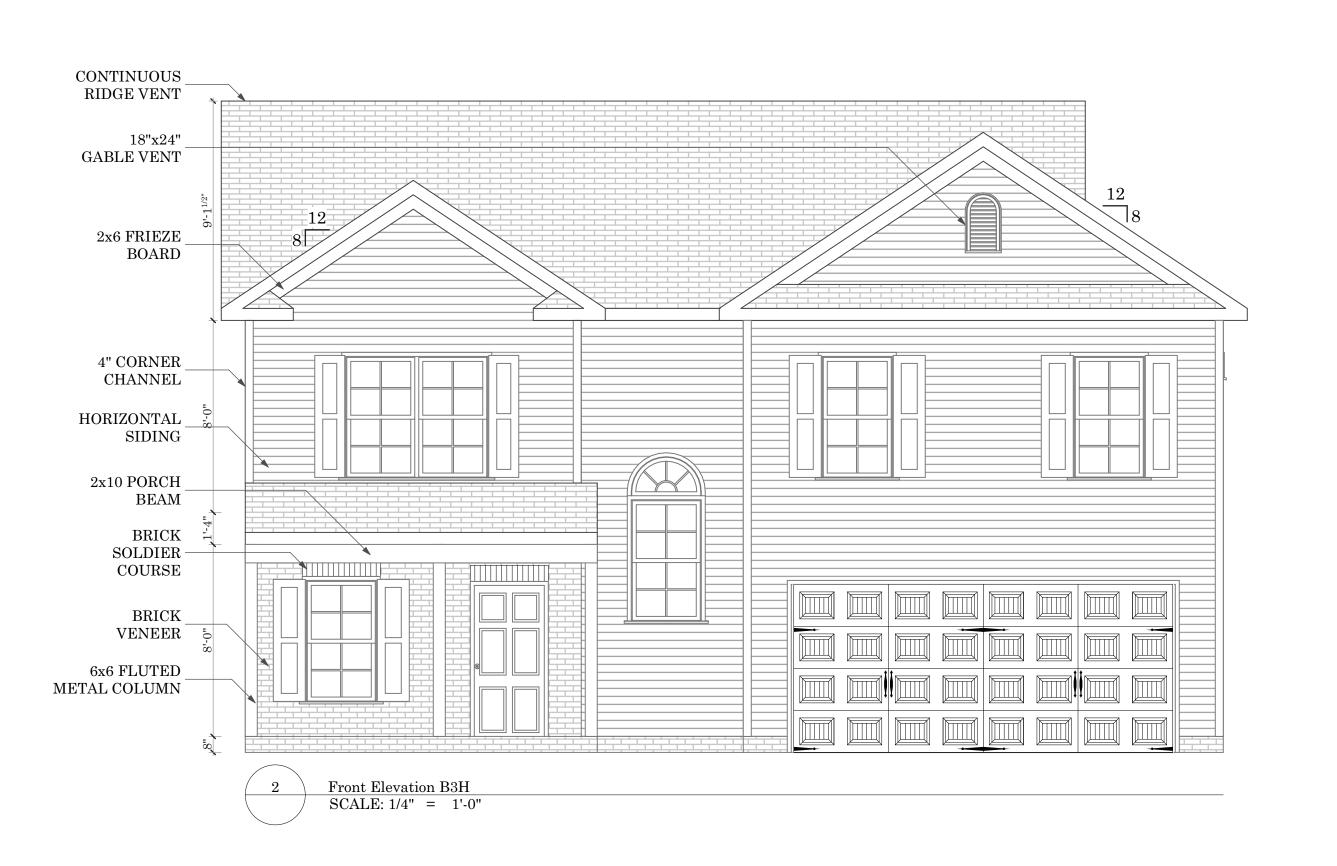
Structural

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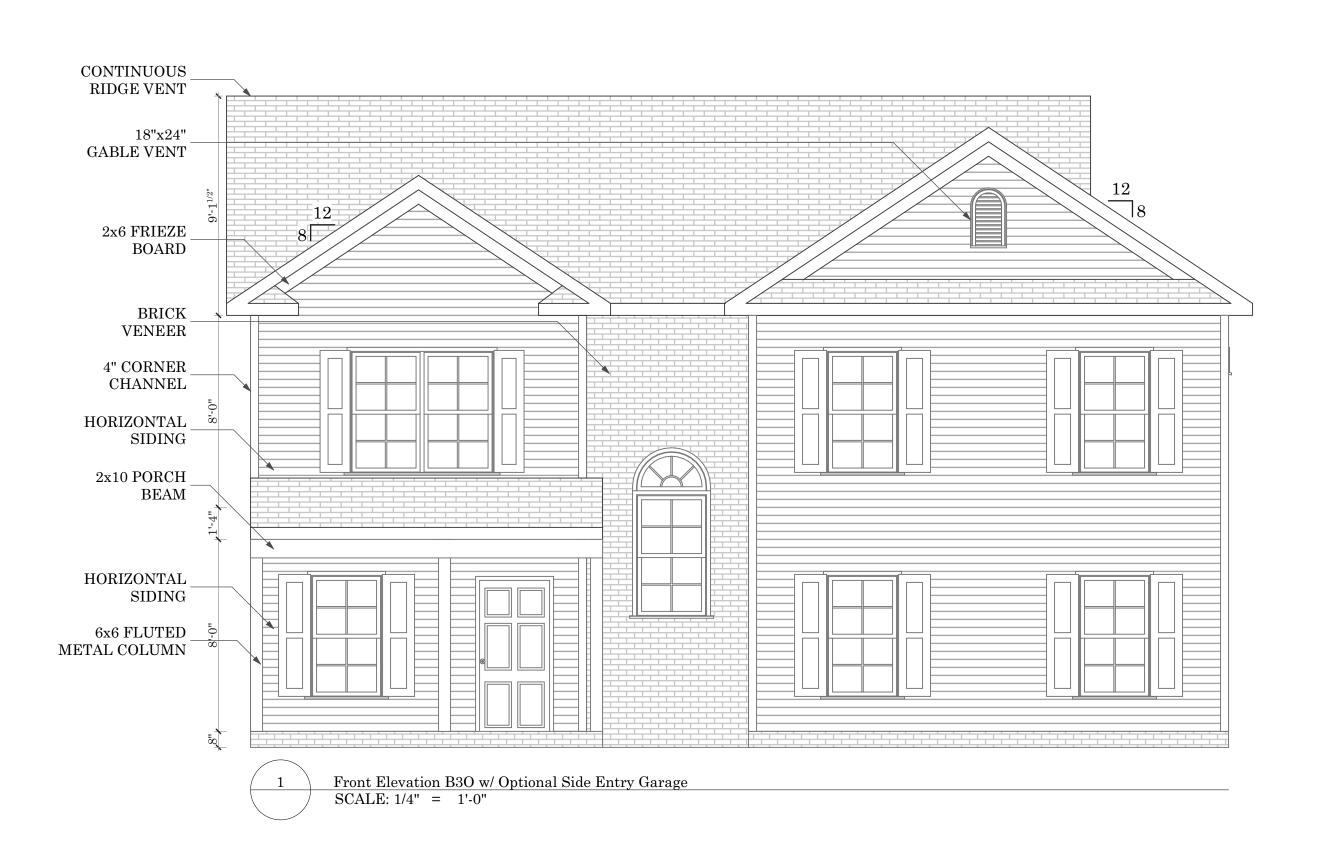
Sheet Name:

Elevations

Sheet Number:











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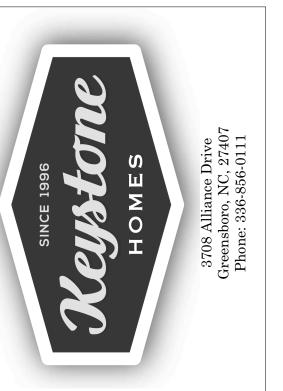
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Elevations

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B-05.1





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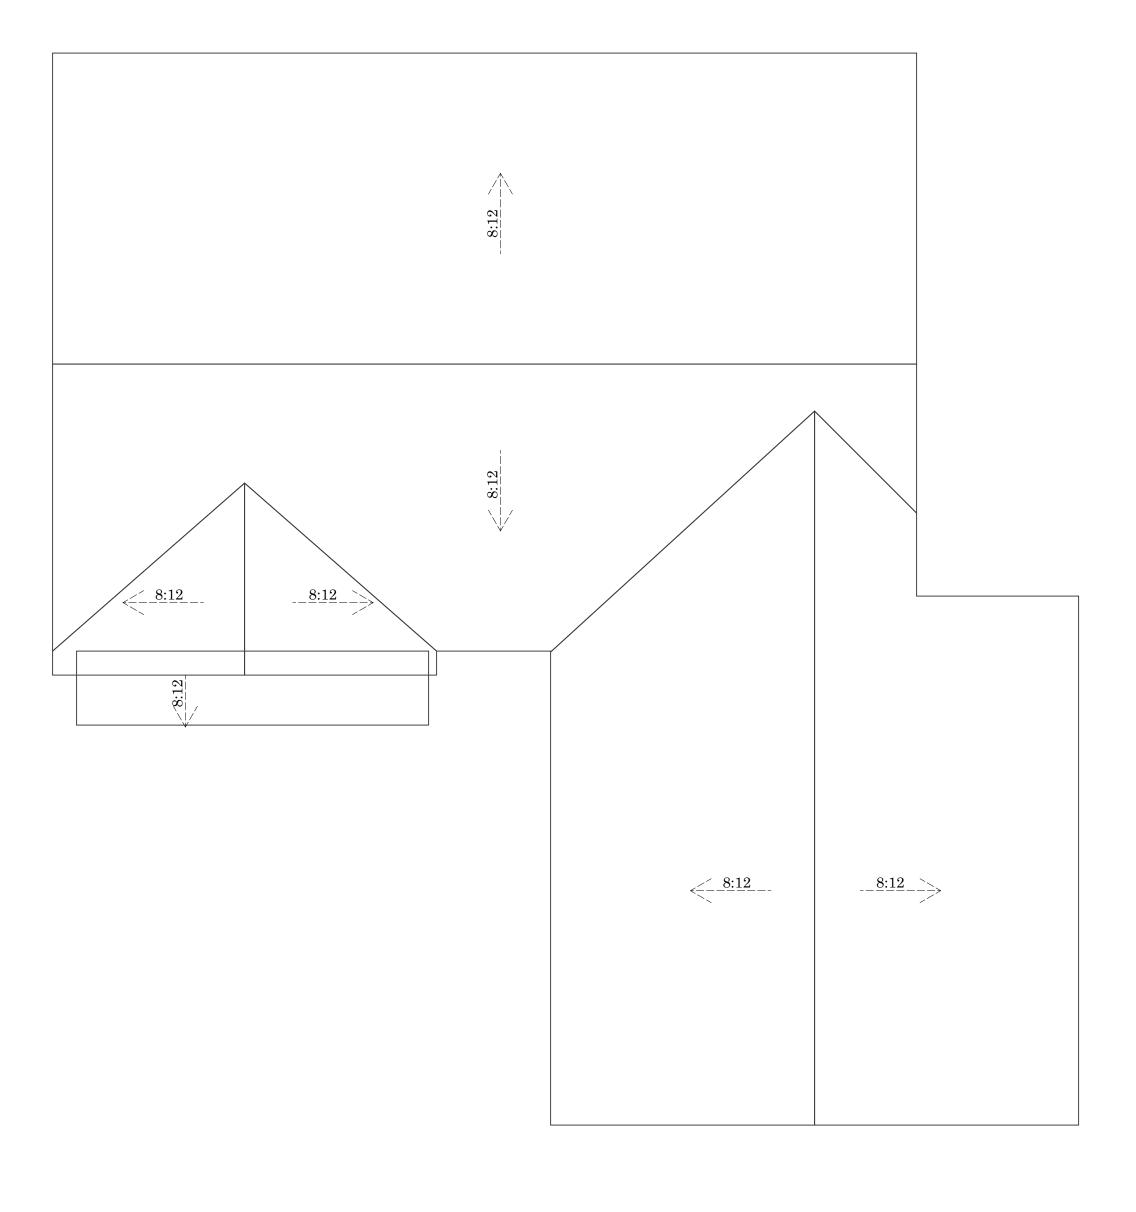
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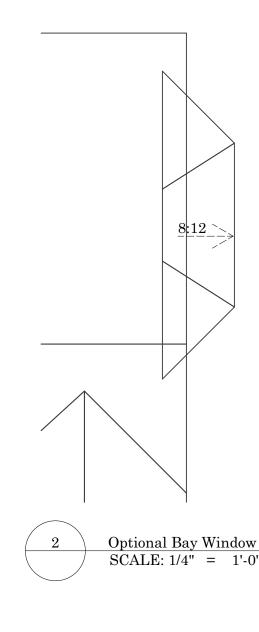
Revision Date	Revision
07/07/15	ADDED SIDE ENTRY GARAGE OPTION

Sheet Name:

Secondary Elevations

Sheet Number:





SINCE 1996

CLEASTORE
HOMES

3708 Alliance Drive
Greensboro, NC, 27407
Phone: 336-856-0111

Burlington

Drawn By:
Tonya K./ Humberto L.
Date Plotted:
4/17/20

4/17/20

Original Date:

01/01/07

File Path:
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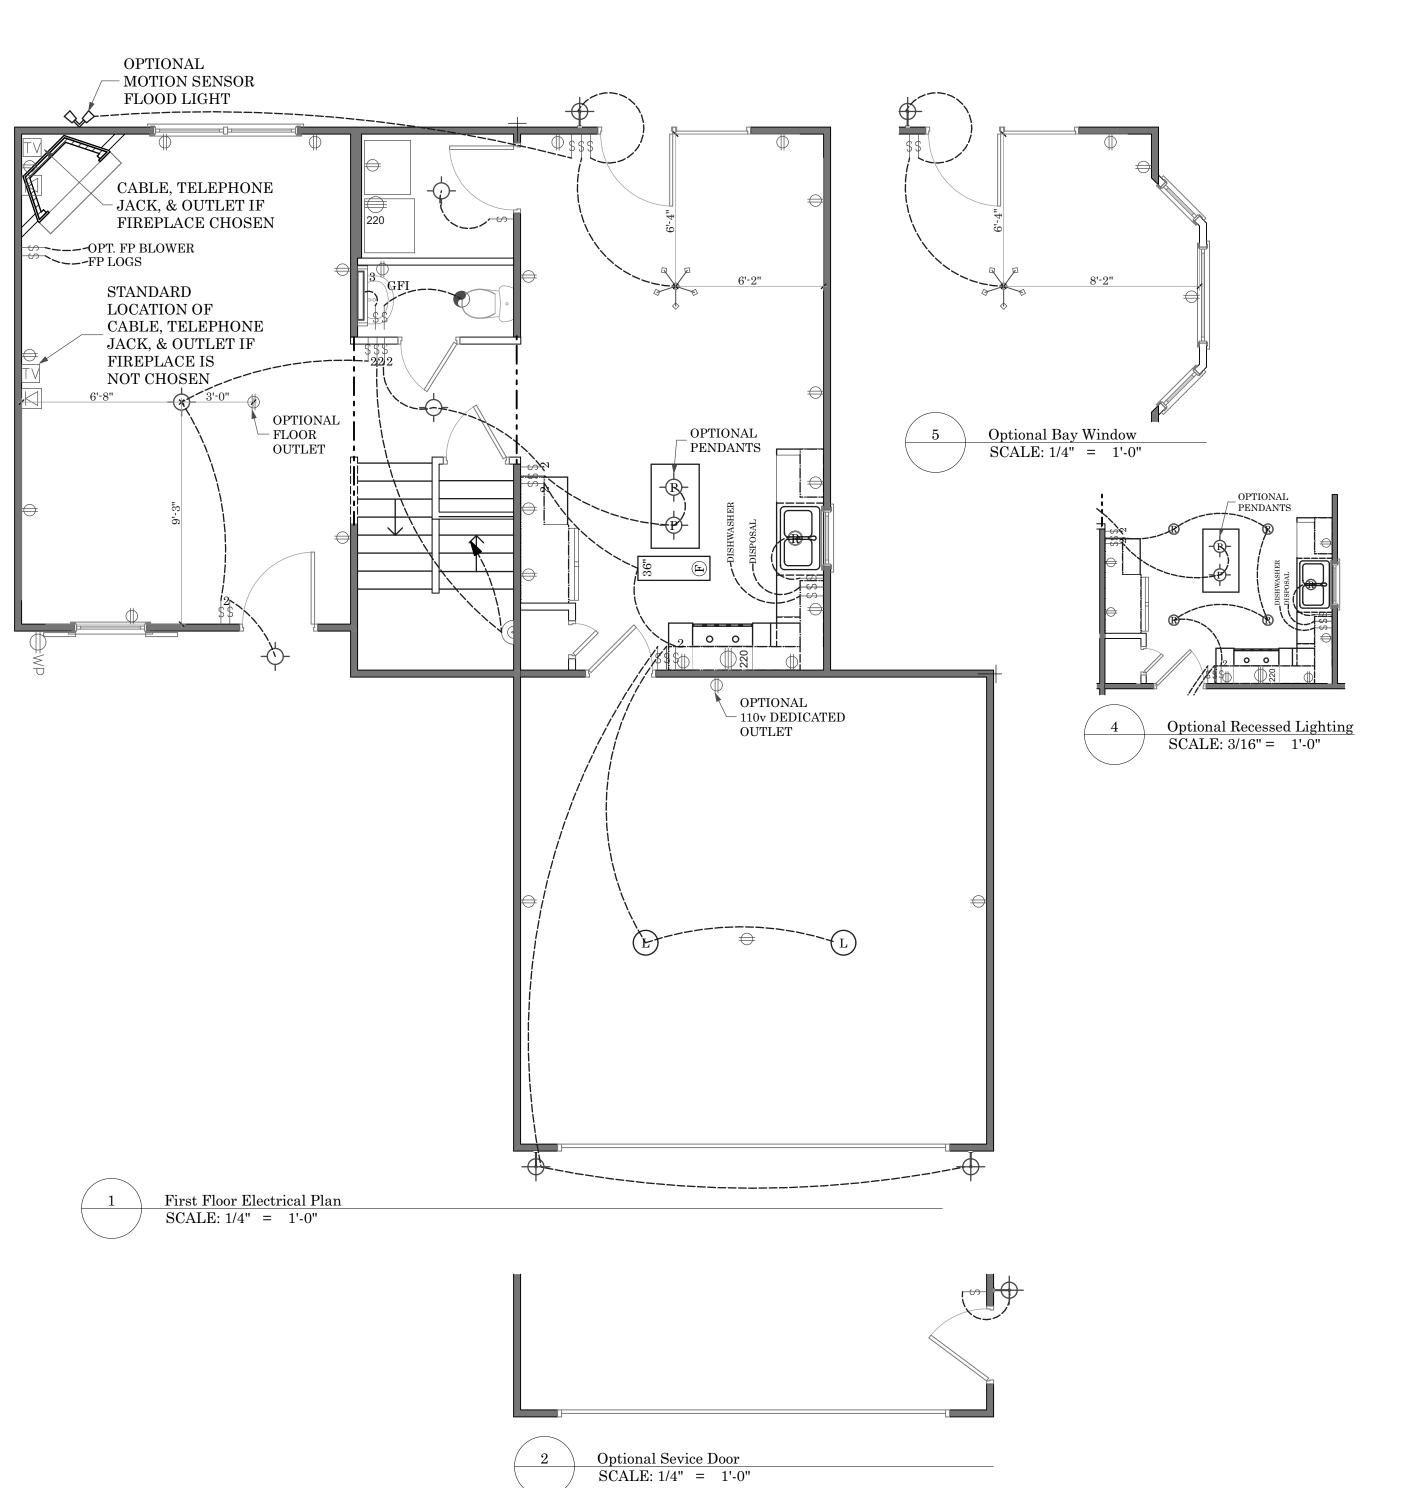
Professional Engineer:

Revision Date Revision


Sheet Name:

Roof Plan

Sheet Number:





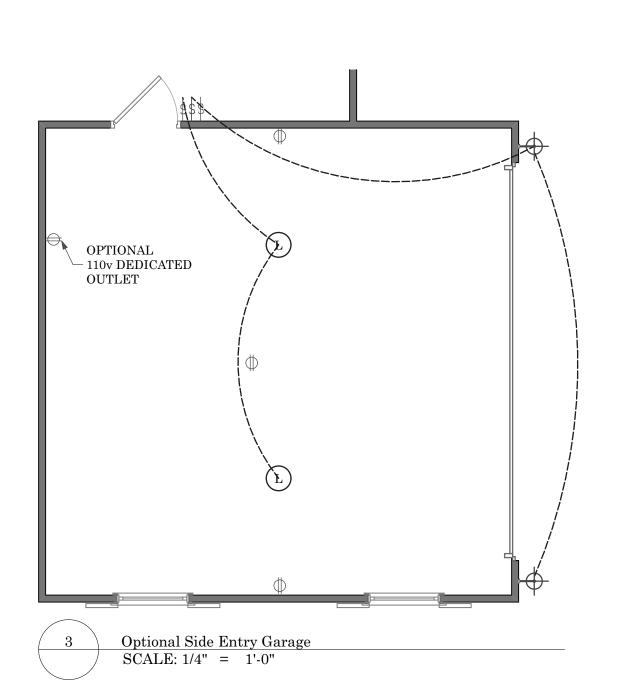



Drawn By:
Tonya K./ Humberto L.
Date Plotted:
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Professional Engineer:

Revision Date	Revision


Sheet Name:


First Floor Electrical Plans


Sheet Number:


E-01

	-SP-	SEMI-FLUSH MOUNT FOYER LIGHT	\ominus	110 VOLT DUPLEX OUTLET	0	BATHROOM EXHAUST FAN
	- - -	PENDANT LIGHT		FLOOR 110 VOLT DUPLEX OUTLET	-00	BATHROOM EXHAUST FAN/ LIGHT COMBO
	*	CHANDELIER	\bigoplus_{GF}	GROUND FAULT 110 VOLT DUPLEX OUTLET		
	© 24"	FLOURESCENT (WITH LENGTH)	\rightleftharpoons_{WP}	WATER PROOF 110 VOLT DUPLEX OUTLET		
	6"	CEILING FAN (WITH ROD LENGTH)	220	220 VOLT OUTLET		
	LT 6"	CEILING FAN WITH LIGHT (WITH ROD LENGTH)		TCH OUTLETS		
	®	RECESS CAN LIGHT	\$	SINGLE POLE SWITCH		
	® SLOPED	SLOPED RECESS CAN LIGHT	\$	DOUBLE POLE SWITCH		
	0	EYEBALL RECESS CAN LIGHT	\$ ₃	THREE WAY SWITCH		
	0	VAPOR PROOF RECESS CAN LIGHT	\$ ₄	FOUR WAY SWITCH		
		VANITY FIXTURE (WITH NUMBER OF LIGHTS)	\$ _D	DIMMER SWITCH		
		WALL MOUNTED LIGHT	COMMUNI	ICATIONS DEVICES		
	\(\phi\)	WALL MOUNTED COACH LIGHT	NCP	NETWORK CABLE ENCLOSURE PANEL		
	<u> </u>	WALL MOUNTED SCONCE	\Box	TELEPHONE OUTLET		
		STAIRWAY TREAD LIGHTS	TV	CABLE OUTLET		
© COMBINATION SMOKE/	(SD)	SMOKE DETECTOR	AVS	AUDIO/VIDEO SOURCE		
CARBON MONOXIDE ALARMS TO BE INSTALLED OUTSIDE	(L)	KEYLESS LAMPHOLDER	A	AUDIO SPEAKER		
OF ALL SLEEPING AREAS	CL	UNDER CABINET COUNTER LIGHT				

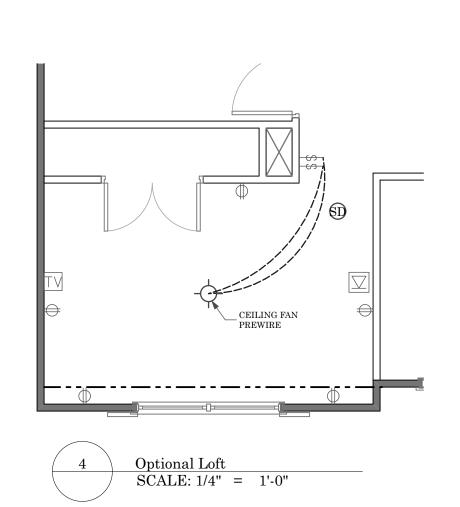

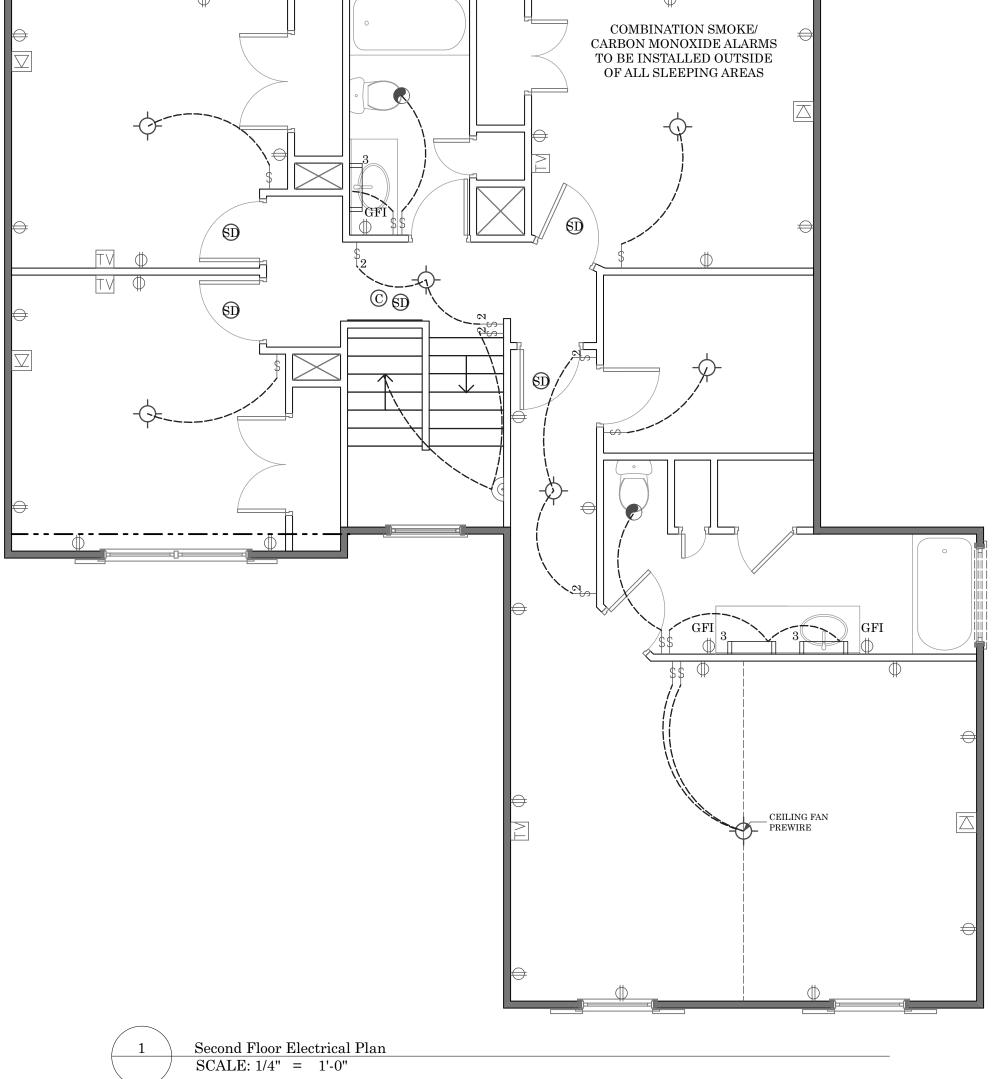

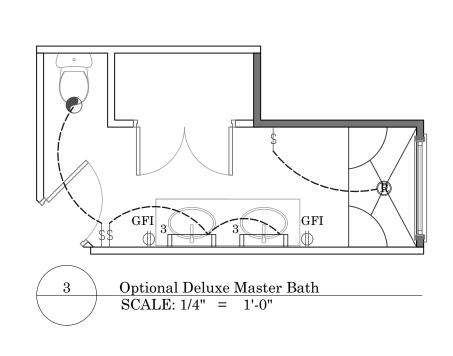

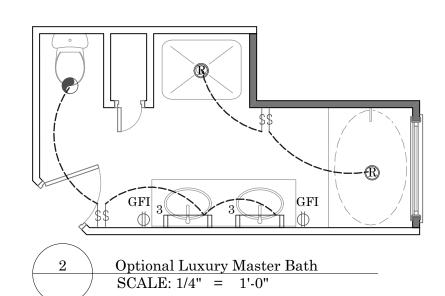



ELECTRICAL SYMBOLS LEGEND

EP ELECTRICAL PANEL

LIGHTING OUTLETS

- CEILING MOUNT LIGHT

CONVENIENCE OUTLETS | MECHANICAL DEVICES

T HVAC THERMOSTAT

Burlington

Drawn By:
Tonya K./ Humberto L.
Date Plotted:

4/17/20 Original Date: 01/01/07

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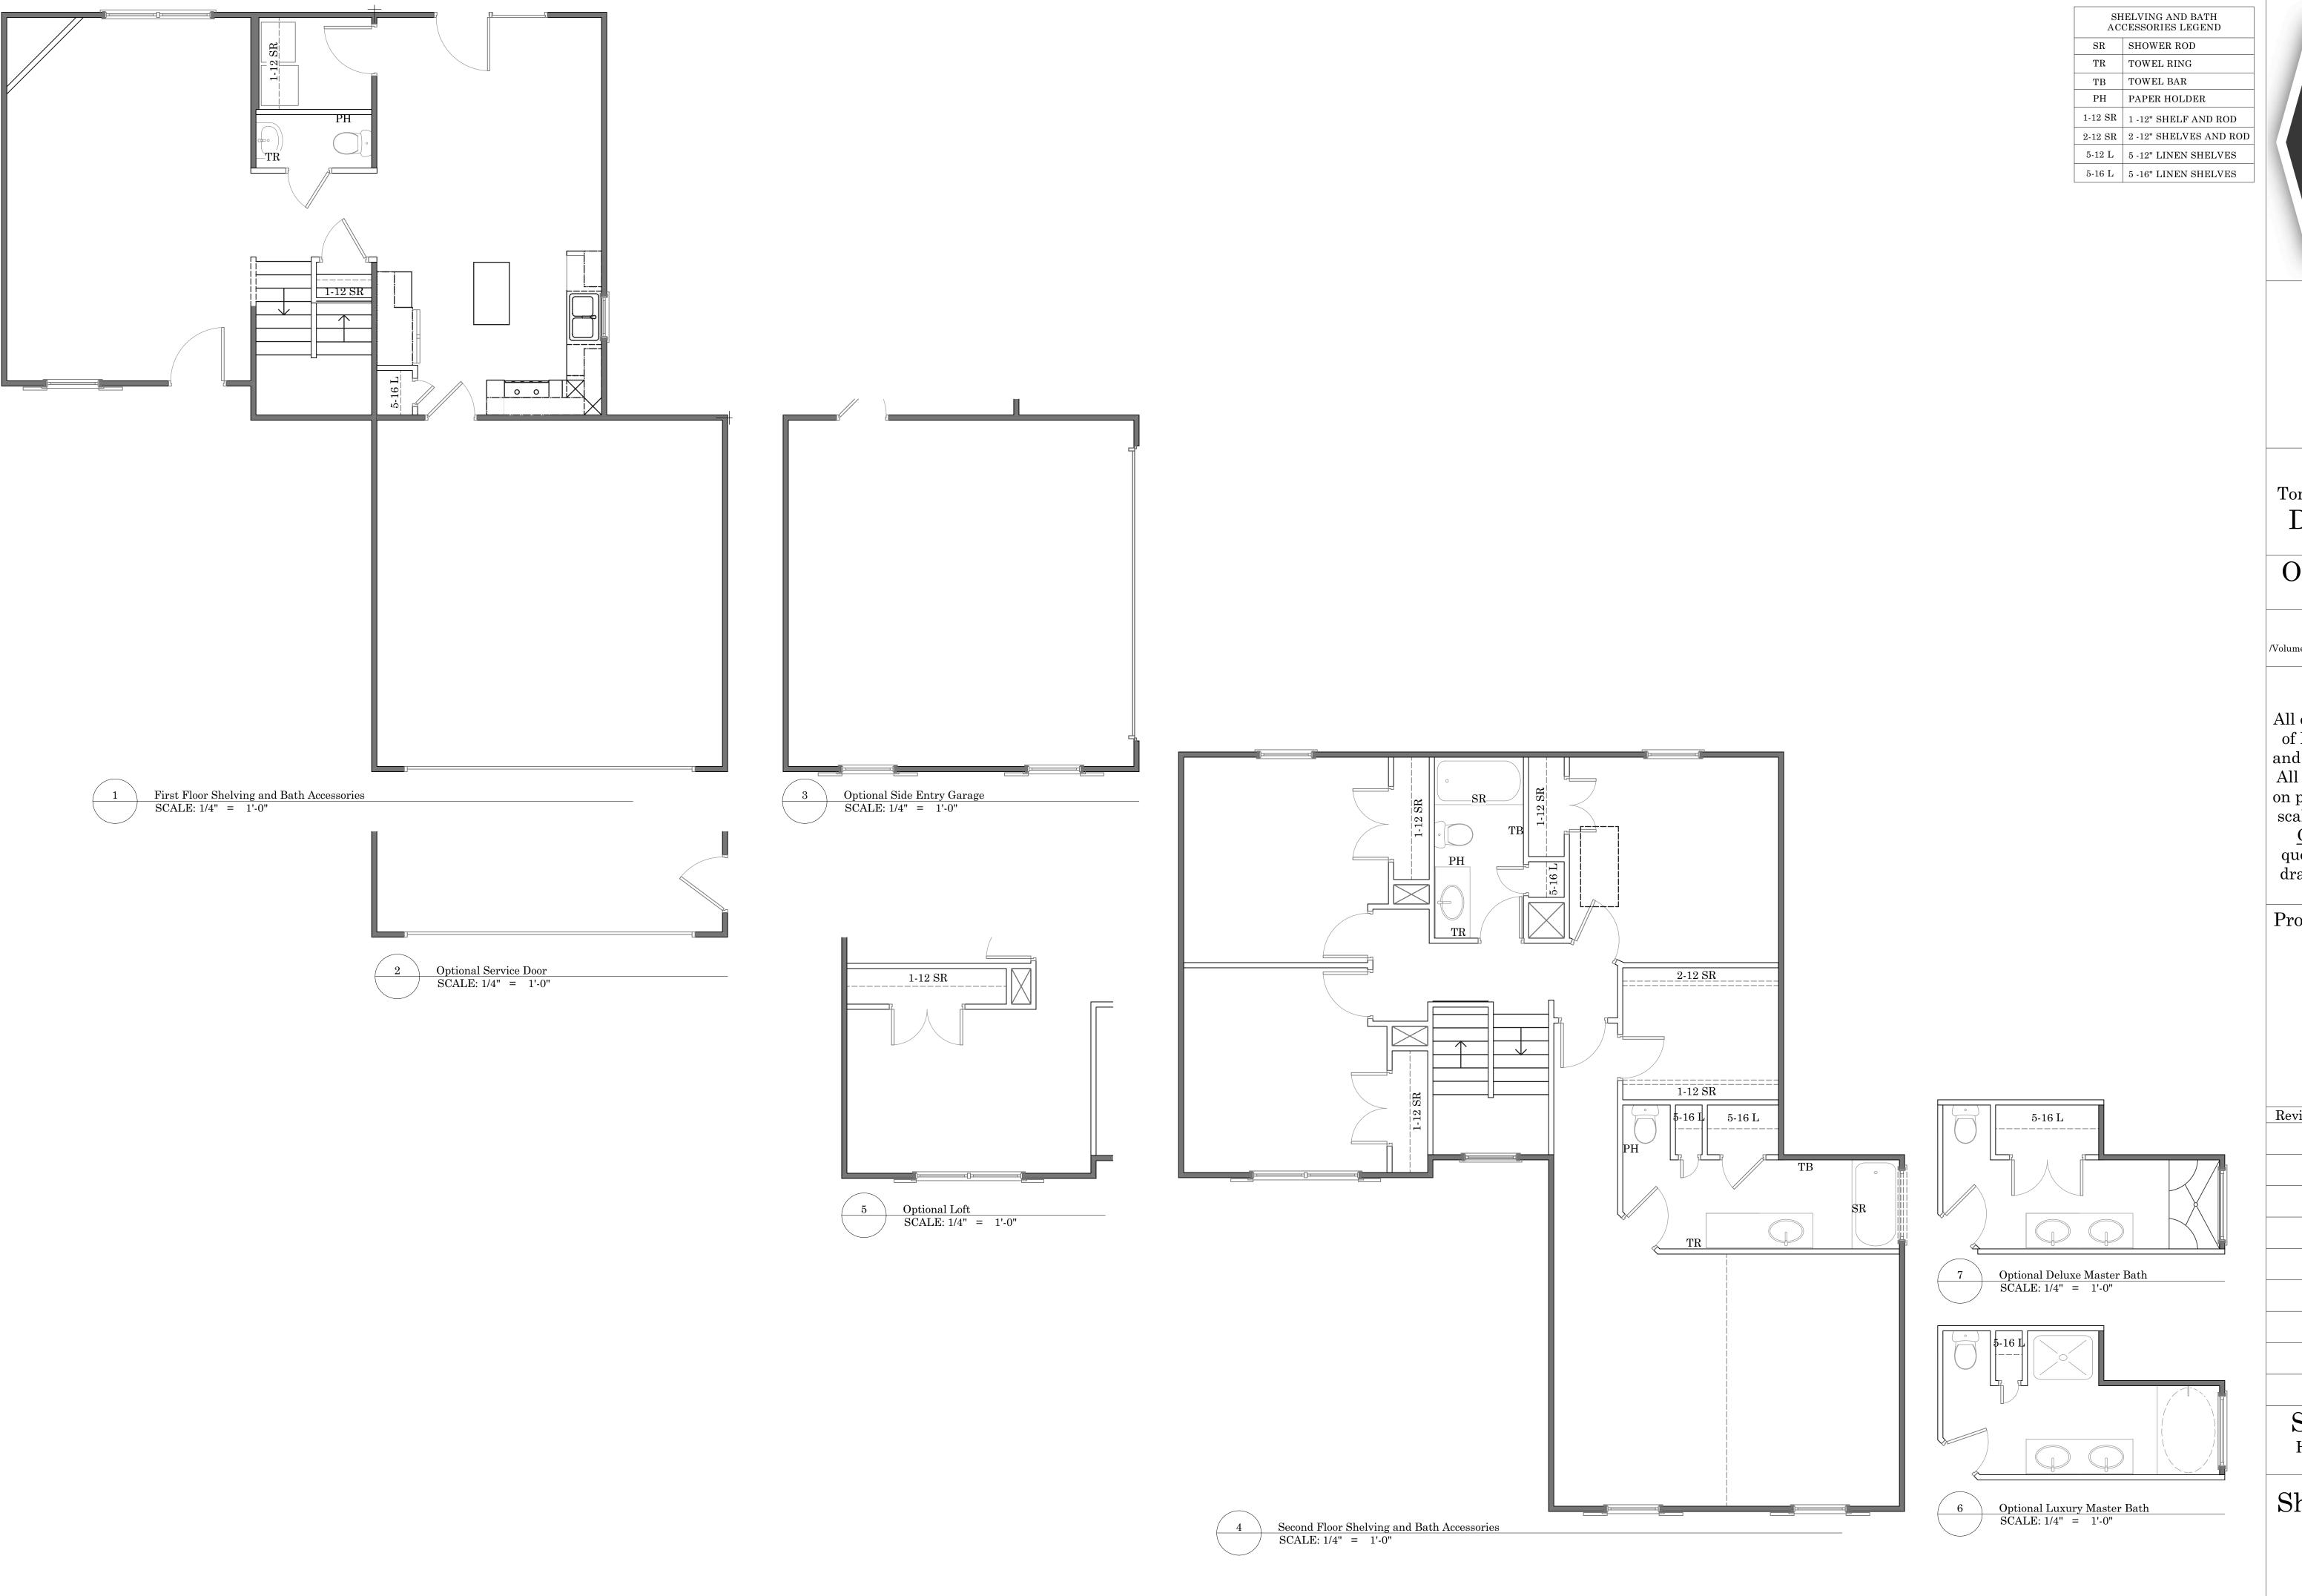
Professional Engineer:

Revision Date	Revision

Sheet Name:
Second Floor Electrical
Plans

Sheet Number:

E-02





Drawn By:
Tonya K./ Humberto L.
Date Plotted:
4/17/20

Original Date: 01/01/07

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Professional Engineer:

D D .	ъ
Revision Date	Revision

Sheet Name:
Hardware and Bath
Accessories

Sheet Number:


H-01

Design Loads			
Use	Live Load (PSF) (TableR301.4)	Dead Load (PSF)	Deflecti
EXTERIOR BALCONIES	60	10	
DECKS	40	10	
FIRE ESCAPES	40	10	
PASSENGER VEHICLE GARAGES	50	10	
ATTICS WITHOUT STORAGE	10	10	
ATTIC WITH STORAGE	20	10	
ROOMS OTHER THAN SLEEPING ROOMS	40	10	
SLEEPING ROOMS	30	10	
STAIRS	40		
GUARDRAILS AND HANDRAILS	200		

SOME FINISHED MATERIALS SUCH AS FLOOR COVERINGS, WALL COVERINGS AND ANY RELATED TRIM WORK MAY NOT BE FOUND IN THIS PLAN. THESE ITEMS ARE TO BE DETERMINED BY THE BUYER AND/OR AND SIGNED FOR ON SELECTION SHEET AND/OR JIO.

ALL WALLS ARE TO BE MEASURED @ 3 1/2" UNLESS OTHERWISE NOTED.

THIS RESIDENCE IS NOT DESIGNED FOR A SPECIFIC LOT/GRADE CONDITION. IT IS THE BUILDERS RESPONSIBILITY TO MAKE SURE FOUNDATION WALLS, POSITIVE DRAINAGE, AND GRADING ARE COMPLETED AND/OR INSTALLEDIN ACCORDANCE WITH CURRENT STATE AND LOCAL BUILDING CODES.

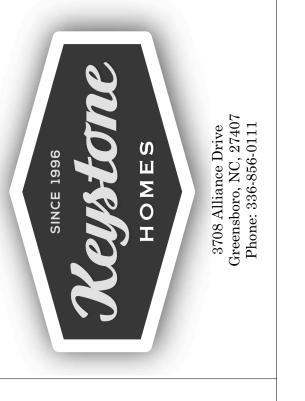

Burlington

Drawn By:
Tonya K./ Humberto L.
Date Plotted:
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Professional Engineer:

10.19.16	INCREASED WIDTH OF CAB ABOVE REF.
05/10/18	CHANGED ISLAND SIZE FROM 24x36 to 24x42
05.10.18	ISLAND CHANGED FROM 24x36 TO 24x42

Revision


Revision Date

Sheet Name:

Information

Sheet Number:

I-01

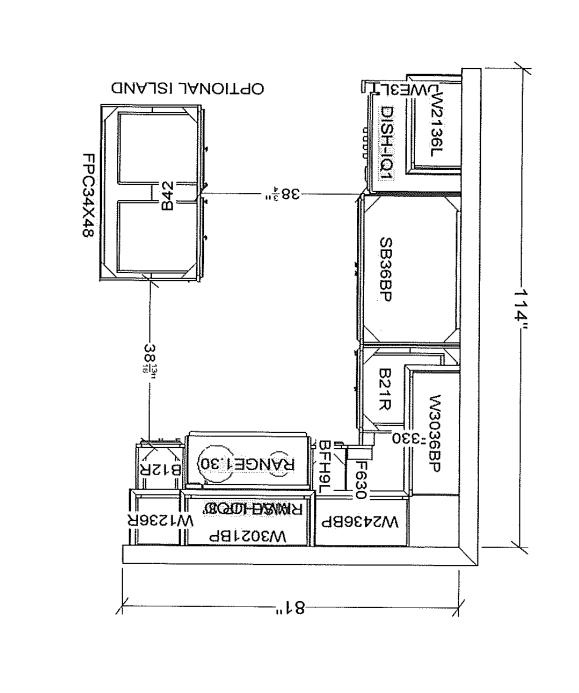

----27"---

Kitchen Layout SCALE: 1:0.60

